

ACTION PLANS

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DEVELOPMENT APPLICATION

THESE PLANS ARE FOR DEVELOPMENT APRROVAL ONLY.

ITEM DETAILS	DEVELOPMENT APPLICATION												
ADDRESS	56 SPENCER ROAD, MOSMAN, NSW	/, 2088											
LOT & DP/SP	LOT 3 DP 508011												
COUNCIL	MOSMAN												
SITE AREA	232.7m ²												
FRONTAGE	6.015m												
CONTROLS	PERMISSIBLE / REQUIRED	EXISTING	PROPOSED	COMPLIANCE									
CONTROLS	m / m² / %	m / m² / %	m / m² / %										
LEP													
LAND ZONING	R2 – LOW DENSITY RESIDENTIAL	R2	R2	YES									
MINIMUM LOT SIZE	450m ²	232.7m ²	UNCHANGED	YES									
FLOOR SPACE RATIO	0:5 : 1 (116.35m²)	0.63 : 1 (146.56m ²)	UNCHANGED	YES									
MAXIMUM BUILDING HEIGHT	8.5m	8.49m	UNCHANGED	YES									
HAZARDS													
HERITAGE	IDENTIFIED – CONSERVATION AREA SIGNIFICANCE: LOCAL	N/A	N/A	N/A									
DCP													
LANDSCAPE AREA	25% (58.175m ²)	26% (60.17m²)	26% (59.44 m ²)	YES									
PRINCIPAL PRIVATE OPEN SPACE	18m²	81.84m ²	UNCHANGED	YES									
FRONT SETBACK	ESTABLISHED BUILDING LINE	6.3m	UNCHANGED	YES									
REAR SETBACK	ESTABLISHED BUILDING LINE	9.2m	UNCHANGED	YES									
SIDE SETBACKS	0.9m	E: N/A W: 0.962m	E: UNCHANGED W: UNCHANGED	YES YES									
CAR PARKING SPACES	REQUIRED: 1	0	1	YES									



- SURFACE SUBSOIL-STORMWATER DRAINAGE - PART 3.1.2 OF NCC - TERMITE-RISK MANAGEMENT - PART 3.1.3 OF NCC - FOOTINGS & SLAB - PART 3.2 OF NCC INCLUDING AS2870 - MASONRY CONSTRUCTION - PART 3.3 OF NCC INCLUDING AS3700 - SUB FLOOR VENTILATION - PART 3.4.1 OF NCC - FRAMING - PART 3.4 OF NCC - GLAZING - PART 3.6 OF NCC INCLUDING AS1288 - FIRE SEPARATION - PART 3.7.1 OF NCC - SMOKE ALARMS - PART 3.7.2 OF NCC - HEATING APPLIANCES - PART 3.7.3 OF NCC - MINIMUM ROOF HEIGHTS - PART 3.8.3 OF NCC - LIGHT: NATURAL AND ARTIFICIAL - PART 3.8.4 OF NCC - VENTILATION & LOCATION OF TOILETS - PART 3.8.5 OF NCC - SOUND INSULATION - PART 3.8.6 OF NCC - BALUSTRADES & OTHER BARRIERS - PART 3.9.2 OF NCC - FENCING & OTHER PROVISIONS - REGS & AS1926 - ALL PLUMBING & DRAINAGE WORK TO COMPLY WITH AS 3500 - SITE CLASSIFICATION AS TO AS 2870 - ALL PLASTERBOARD WORK TO COMPLY WITH AS 2588-1998 - ALL CONCRETE WORK TO COMPLY WITH AS 3600 - ALL ROOF SHEETING WORK TO COMPLY WITH AS 1562-1992 - ALL SKYLIGHTS TO COMPLY WITH WITH AS 4285-2007 - ALL GLAZING ASSEMBLIES TO COMPLY WITH AS2047 & 1288 AS 1720.2-2006, AS 1720.4-2006, AS 1170.1-1989 & AS 1170.4-1993 - ALL CONSTRUCTION TO COMPLY TO AS3959- 1991

- EARTHWORKS: METHOD OF EXCAVATION AND FILL - PART 3.1.1 OF NCC - ROOF, WALL-CLADDING, GUTTERS & DOWNPIPES - PART 3.5 OF NCC - WET AREAS-PROTECTION OF WALLS & FLOORS - PART 3.8.1 OF NCC - FACILITIES REQUIRRED & SANITARY DOOR CONSTRUCTION - PART 3.8.3 OF NCC - STAIR CONSTRUCTION INCLUDING DIMENSIONS - PART 3.9.1 OF NCC - DEMOLITION WORKS - AS2601-1991 THE DEMOLITION OF STRUCTURES. - ALL WATERPROOF MEMBRANES TO COMPLY WITH WITH AS 3740-2004 - ALL STRUCTURAL STEEL WORK TO COMPLY WITH AS 4100 & AS 1554 - ALL CERAMIC TILING TO COMPLY WITH AS 3958.1-2007 & 3958.2-1992 - ALL TIMBER RETAINING WALLS ARE TO COMPLY WITH AS 1720.1-2010, - ALL RETAINING WALLS ARE TO COMPLY WITH 3700 - 2011 & AS 3600 - 2001

SHEET NUMBER	SHEET NAME	DATE PUBLISHED
DA00	COVER	13/12/2021
DA01	NOTES	13/12/2021
DA02	SITE ANALYSIS	13/12/2021
DA03	SITE / ROOF PLAN	13/12/2021
DA04	SEDIMENT / EROSION CONTROL PLAN	13/12/2021
DA05	EXISTING GROUND FLOOR PLAN	13/12/2021
DA06	PROPOSED GROUND FLOOR PLAN	13/12/2021
DA07	EXISTING FIRST FLOOR PLAN	13/12/2021
DA08	NORTH ELEVATION	13/12/2021
DA09	EAST / WEST ELEVATION	13/12/2021
DA10	DRIVEWAY LONG SECTION	13/12/2021
DA11	AREA CALCULATIONS	13/12/2021

56 SPENCER ROAD, **MOSMAN NSW 2088**



NCC & AS COMPLIANCES SPECIFICATIONS

NOTES

• APPROVED MEANS BY THE 'RELEVANT LOCAL AUTHORITY' OR COUNCIL

• THE OWNER WILL DIRECTLY PAY THE FEES ASSOCIATED WITH THE FOLLOWING:

BUILDING APPROVAL FROM COUNCIL, FOOTPATHAND KERB DEPOSITS WITH THE LOCAL COUNCIL, INSURANCE FEE TO BUILDING SERVICES CORPORATION, LONG SERVICE LEAVE SERVICE LEVY FEE AND APPROVAL FEE BY WATER AND SEWERAGE AUTHORITY. ALL OTHER FEES ARE TO BE PAID BY THE BUILDER. THE AMOUNT OF ANY LOCAL AUTHORITY DEPOSITS WHICH ARE FORFEITED DUE TO DAMAGE OR OTHER CAUSE WILL BE DEDUCTED FROM THE PAYMENTS DUE TO THE BUILDER.

• THE BUILDER IS TO PROVIDE AT HIS/HER OWN EXPENSE ADEQUATE PUBLIC RISK INSURANCE AND ARRANGE INDEMNIFICATION UNDER THE WORKERS COMPENSATION ACT. WORKS INSURANCE TO BE STATED IN THE CONTRACT CONDITIONS.

• ALL WORK TO BE CARRIED OUT IN A TRADESMEN LIKE MANNER AND IN ACCORDANCE WITH THE STANDARDS CODES AND REGULATIONS OF THE STANDARDSS ASSOCIATION OF AUSTRALIA. BUILDING CODE OF AUSTRALIA AND ANY STATUTORY AUTHORITY HAVING JURISDICTION OVER THE WORK.

• ALL TENDERERS ARE TO VISIT THE SITE TO SATISFY THEMSELVES AS TO THE NATURE AND EXTENT OF THE WORKS, FACILITIES AVAILABLE AND DIFFICULTIES ENTAILED IN THE WORKS AS VARIATIONS WILL NOT BE ALLOWED DUE TO WORK ARISING OWING TO NEGLECT OF THIS CLAUSE.

• ALL WORK AND MATERIALS TO COMPLY WITH THE CURRENT AUSTRALIAN STANDARDS AT THE TIME OF COMMENCEMENT WERE APPLICABLE.

• THESE DRAWINGS SHALL BE READ IN CONJUNCTION WITH ALL STRUCTURAL AND OTHER CONSULTANTS DRAWINGS AND SPECIFICATIONS AND WITH ANY SUCH WRITTEN INSTRUCTIONS AS MAY BE ISSUED. DURING THE COURSE OF THE CONTRACT.

• SET OUT DIMENSIONS SHOWN ON THIS DRAWING SHALL BE VARIFIED BY THE BUILDER ON SITE BEFORE COMMENCEMENT OF ANY WORK, DIMENSIONS SHOULD NOT BE OBTAINED BY SCALING THE DRAWINGS. USE ONLY FIGURED DIMENSIONS, ALL DIMENSIONS ARE IN MILLIMETRES.

• THE BUILDER IS TO ENSURE ALL CONSTRUCTION. LEVELS AND OTHER ITEMS COMPLY WITH THE CONDITIONS OF THE BUILDING APPROVAL.

• THE BUILDER IS TO COMPLY WITH ALL ORDINANCES, LOCAL AUTHORITY REGULATIONS AND THE REQUIREMENTS OF ALL SERVICES SUPPLY AUTHORITIES HAVING JURISDICTION OVER THE WORKS. • ALL PLUMBING AND DRAINAGE WORK TO BE INSTALLED AND COMPLETED BY A LICENCED TRADESMAN AND IN ACCORDANCE WITH THE STATUTORY BODY HAVING AUTHORITY OVER THE WORKS. CONNECT ALL WASTE TO SYDNEY WATER SEWER LINE

ALL NEW DOWNPIPES ARE TO BE CONNECTED TO THE EXISTING STORM WATER SYSTEM.

ALL POWER AND STORMWATER OUTLET LOCATIONS SHALL BE DETERMINED ONSITE BY THE OWNER.

SMOKE DETECTOR ALARM TO BE INSTALLED IN ACCORDANCE WITH AS3786 AND THE BUILDING CODE OF AUSTRALIA.

• ELECTRICAL WORK TO BE IN ACCORDANCE WITH SAA WIRING RULES AND BE DONE BY A LICENCED TRADESMAN

• ANY DETAILING IN ADDITION TO WHAT IS SUPPLIED SHALL BE RESOLVED BETWEEN THE OWNER AND THE BUILDER TO THE OWNERS APPROVAL, EXCEPT FOR ANY STRUCTURAL DETAILS OR DESIGN WHICH IS SUPPLIED BY THE ENGINEER.

ALL TIMBER SIZES AND CONCRETE DETAILS TO BE CONFIRMED BY THE BUILDER PRIOR TO COMMENCEMENT OF ANY WORK.

• ALL STRUCTURAL WORK IS TO BE IN ACCORDANCE WITH THE STRUCTURAL DETAILS PREPARED BY A STRUCTURAL ENGINEER (i.e.) PIERS, FOOTINGS, CONCRETE SLABS, RETAINING WALLS, STEELWORK, FORMWORK, UNDERPINNING, ADDITIONAL STRUCTURAL LOADS, TIMBER FRAMING, WIND BRACING AND ASSOCIATED CONNECTIONS. BUILDER TO OBTAIN PRIOR TO FINALISING TENDER.

• ANY WORK INDICATED ON THE PLANS BUT NOT SPECIFIED, AND ANY ITEM NOT SHOWN ON THE PLAN WHICH IS OBVIOUSLY NECESSARY AS A PART OF CONSTRUCTION AND/OR FINISH IS TO BE CONSIDERED AS SHOWN AND SPECIFIED, AND IS TO BE DONE AS PART OF THE CONTRACT. VARIATIONS WILL NOT BE PERMITTED WITHOUT THE WRITTEN CONSENT OF THE OWNER.

• THE BUILDER SHALL PROVIDE SEDIMENT AND SILTRATION CONTROL MEASURES AS REQUIRED BY COUNCIL AND MAINTAIN THEM THROUGH THE DURATION OF THE WORKS.

• A LEGIBLE COPY OF THE PLANS BEARING APPROVAL STAMPS MUST BE MAINTAINED ON THE JOB AT ALL TIMES. HOURS OF CONSTRUCTION WILL BE RESTRICTED TO THE TIMES AS REQUIRED BY THE BUILDING APPROVAL.

• THE BUILDER IS TO ARRANGE FOR ALL INSPECTIONS REQUIRED BY THE AUTHORITIES AND LENDING INSTITUTIONS TO THEIR REQUIREMENTS.

• THE BUILDER IS TO OBTAIN APPROVAL FOR INTERUPTIONS TO EXISTING SERVICES AND MINIMISE THE DURATION AND NUMBER OF INTERUPTIONS. ANY INTERRUPTIONS WITH EXISTING SERVICES AND EQUIPMENT TO BE ATTENDED TO BY THE APPROPRIATELY SKILLED TRADESMEN.

• THE BUILDER SHALL RESTORE, REINSTATE OR REPLACE ANY DAMAGE CAUSED TO EXISTING STRUCTURES OR LANDSCAPING BY CONSTRUCTION WORK OR WORKMEN. PROVIDE PROTECTION TO EXISTING TREES TO REMAIN AS REQUIRED BY APPROVAL CONDITIONS.

ALL BRICKWORK IS TO BE SELECTED BY OWNER AND IS TO COMPLY WITH AS1640

ALL MASONRY TO COMPLY WITH AS3700

ALL METALWORK AND FLASHING ITEMS NECESSARY TO SATISFACTORY COMLPETE WORK SHALL BE PROVIDED.

ALL GUTTERS, DOWNPIPES TO BE COLORBOND.

ALL TIMBER CONSTRUCTION TO BE IN ACCORDANCE WITH THE AUSTRALIAN STANDARD 1684 "TIMBER FRAMING CODE"


ALL GLAZING INSTALLED TO COMPLY WITH AS1288, 2047 AND IN ACCORDANCE WITH MANUFACTURERS RECOMMENDATION


• ALL WALL AND CEILING LININGS TO BE PLASTERBOARD OR CEMENT RENDER AS SELECTED AND VILLA BOARD IN WET AREAS, TO COMPLY WITH THE RELEVANT AUSTRALIAN STANDARDS OR INSTALLED IN ACCORDANCE WITH MANUFACTURERS SPECIFICATION. • ALL BATHROOMS AND WET AREAS TO BE ADEQUATELY WATERPROOFED TO MANUFACTURERS SPECIFATION AND AS3740 AND PART 3.8.1 OF THE BUILDING CODE OF AUSTRALIA HOUSING PROVISIONS

• STRAIRS AND BALISTRADES TO COMPLYWITH PART 3.9.1 & 3.9.2 OF THE BUILDING CODE OF AUSTRALIA HOUSING PROVISION.

TERMITE PROTECTION MEASURES TO COMPLY WITH AS 3660 AND BE INSTALLED TO MANUFACTURERS SPECIFICATION.

• ANY DETAILING ADDITIONAL TO THAT SUPPLIED , SHALL BE RESOLVED BETWEEN THE OWNER AND THE BUILDER TO THE OWNERS APPROVAL. EXCEPT FOR ANY STRUCTURAL DETAILS OR DESIGN WHICH IS TO BE SUPPLIED BY THE STRUCTURAL ENGINEER.

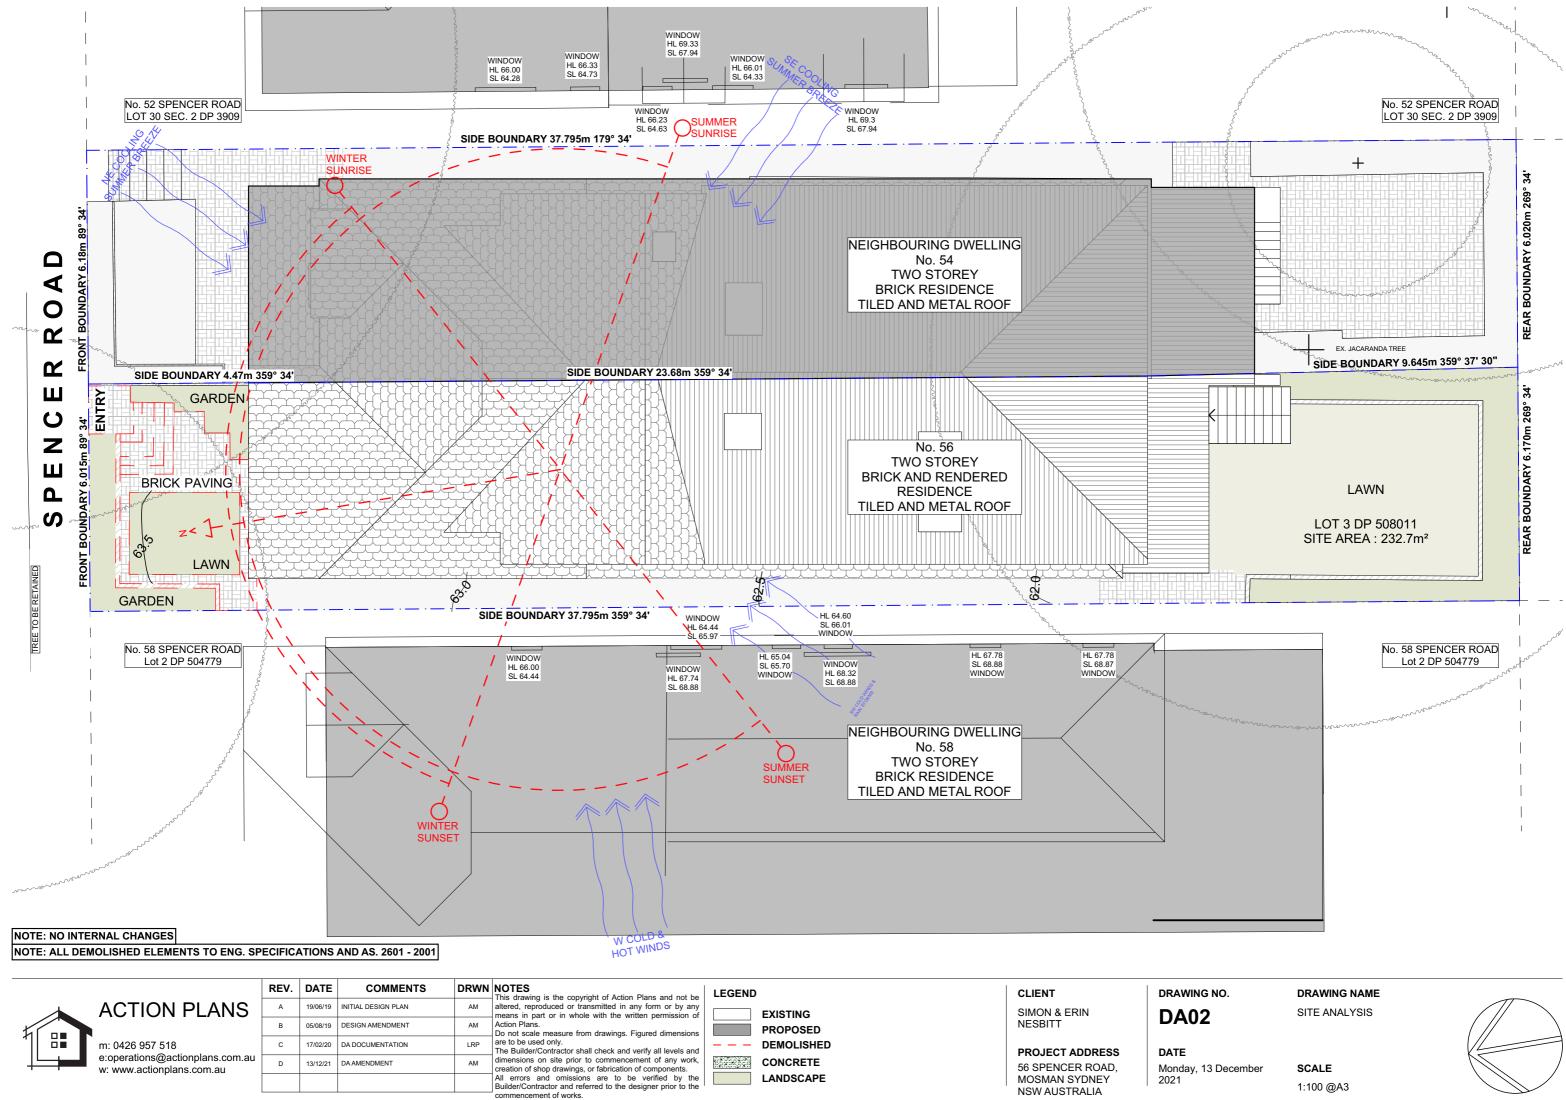

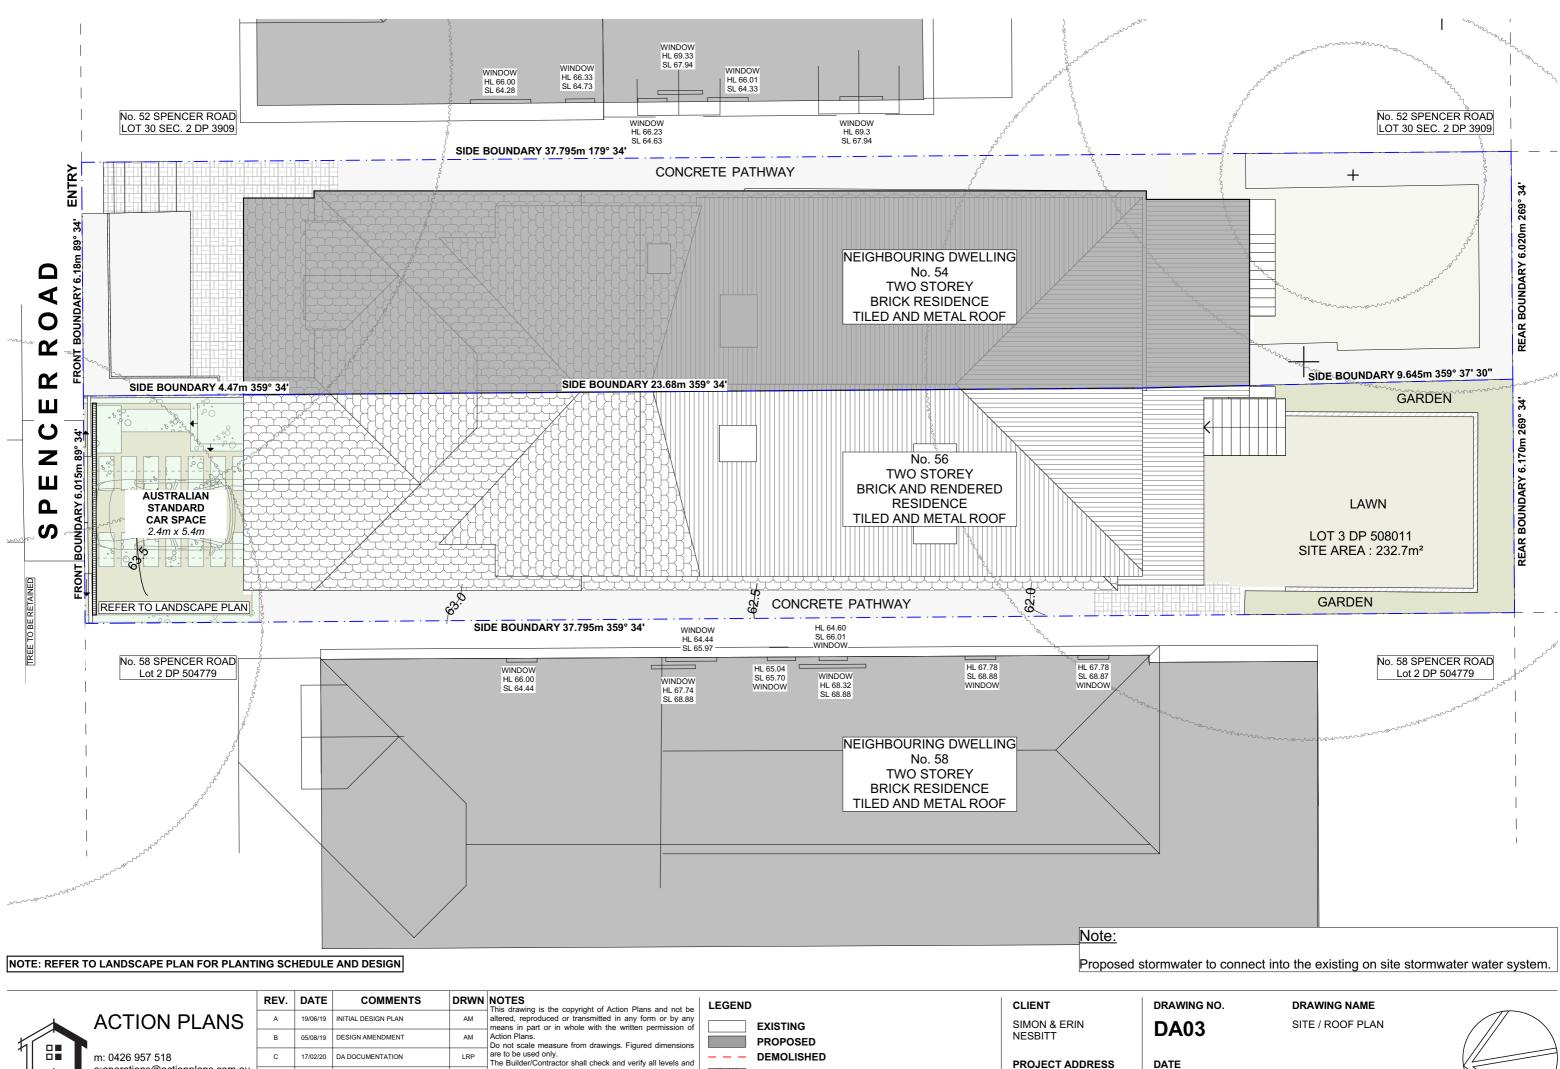

dimensions on site prior to commencement of any work,

creation of shop drawings, or fabrication of components. All errors and omissions are to be verified by the Builder/Contractor and referred to the designer prior to the

mmencement of works.

CONCRETE

LANDSCAPE

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13/12/21

DA AMENDMENT

AM

2021


56 SPENCER ROAD.

MOSMAN SYDNEY

NSW AUSTRALIA

Monday, 13 December

SCALE 1:100 @A3

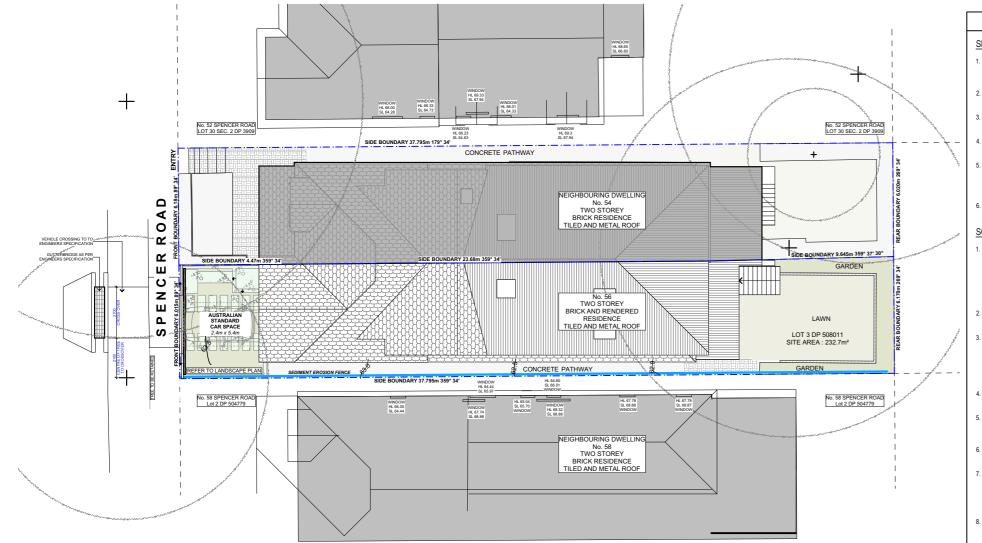


EROSION AND SEDIMENT CONTROL NOTES

SEDIMENT CONTROL INSTRUCTIONS

- SEDIMENT FENCES WILL BE INSTALLED AS SHOWN ON THE PLAN AND ELSEWHERE AT THE DISCRETION OF THE SITE SUPERINTENDENT TO CONTAIN SOIL AS NEAR AS POSSIBLE TO THEIR SOURCE
- SEDIMENT FENCES WILL NOT HAVE CATCHMENT AREAS EXCEEDING 900 SQUARE METRES AND HAVE A STORAGE DEPTH OF AT LEAST 0.6 METRES.
- SEDIMENT REMOVED FROM ANY TRAPPING DEVICES WILL BE RELOCATED WHERE FURTHER POLLUTION TO DOWNSLOPE LANDS AND WATERWAYS CANNOT OCCUR
- STOCKPILES ARE NOT TO BE LOCATED WITHIN 5 METRES OF HAZARD AREAS INCLUDING IGH VELOCITY FLOWS SUCH AS WATERWAYS, PAVED AREAS AND DF
- WATER WILL BE PREVENTED FROM DIRECTLY ENTERING THE PERMANENT DRAINAGE SYSTEM UNLESS THE CATCHMENT AREA HAS BEEN PERMANENTLY LANDSCAPED AND/OR WATER HAS BEEN TREATED BY AN APPROVED DEVICE. 6. TEMPORARY SEDIMENT TRAPS WILL REMAIN IN PLACE UNTIL AFTER THE LANDS THEY ARE PROTECTING ARE COMPLETELY REHABILITATED
- ACCESS TO SITES SHOULD BE STABILISED TO REDUCE THE LIKELIHOOD OF VEHICLES TRACKING SOIL MATERIALS ONTO PUBLIC ROADS AND ENSURE ALL-WEATHER ENTRY/EXIT.

SOIL EROSION CONTROL INSTRUCTIONS

- EARTH BATTERS WILL BE CONSTRUCTED WITH AS LOW A GRADIENT AS PRACTICABLE BUT NO STEEPER, UNLESS OTHERWISE NOTED, THAN
- 2(H):1(V) WHERE SLOPE LENGTH LESS THAN 12 METRES 2.5(H):1(V) WHERE SLOPE LENGTH BETWEEN 12 AND 16 METRES.
- 3(H):1(V) WHERE SLOPE LENGTH BETWEEN 16 AND 20 METRES. 4(H):1(V) WHERE SLOPE LENGTH GREATER THAN 20 METRES.
- ALL WATERWAYS, DRAINS, SPILLWAYS AND THEIR OUTLETS WILL BE CONSTRUCTED TO BE STABLE IN AT LEAST THE 1:20 YEAR ARI, TIME OF CONCENTRATION STORM EVENT
- WATERWAYS AND OTHER AREAS SUBJECT TO CONCENTRATED FLOWS AFTER CONSTRUCTION ARE TO HAVE A MAXIMUM GROUNDCOVER C-FACTOR OF 0.05 (70% GROUND COVER) WITHIN 10 WORKING DAYS FROM COMPLETION OF FORMATION, FLOW VELOCITIES ARE TO BE LIMITED TO THOSE SHOWN IN TABLE 5-1 OF "MANAGING URBAN STORMWATER -SOILS AND CONSTRUCTION", DEPT OF HOUSING 1998 (BLUE BOOK). FOOT AND VEHICULAR FFIC WILL BE PROHIBITED IN THESE AREAS.
- STOCKPILES AFTER CONSTRUCTION ARE TO HAVE A MAXIMUM GROUND-COVER C-FACTOR OF 0.1 (60% GROUND-COVER) WITHIN 10 WORKING DAYS FROM COMPLETION OF FORMATION
- ALL LANDS. INCLUDING WATERWAYS AND STOCKPILES. DURING CONSTRUCTION ARE TO HAVE A MAXIMUM GROUND-COVER C-FACTOR OF 0.15 (50% GROUND COVER) WITHIN 20 WORKING DAYS FROM INACTIVITY EVEN THOUGH WORKS MAY CONTINUE LATER.
- FOR AREAS OF SHEET FLOW USE THE FOLLOWING GROUND COVER PLANT SPECIES FOR TEMPORARY COVER: JAPANESE MILLET 20 KG/HA AND OATS 20 KG/HA.
- PERMANENT REHABILITATION OF LANDS AFTER CONSTRUCTION WILL ACHIEVE A EDWINNEH RELIBIOITATION OF LESS THAN 0.1 AND LESS THAN 0.5 WITH A BOAYS. NEWLY PLANTED LANDS WILL BE WATERED REGULARLY UNTIL AN EFFECTIVE COVER IS ESTABLISHED AND PLANTS ARE OROWING VIGOROUSLY. FOLLOW-UP SEED AND FERTILISER WILL BE APPLIED AS NECESSAR
- RE-VEGETATION SHOULD BE AIMED AT RE-ESTABLISHING NATURAL SPECIES, NATURAL SURFACE SOILS SHOULD BE REPLACED AND NON-PERSISTANT ANNUAL COVER CROPS SHOULD BE USED

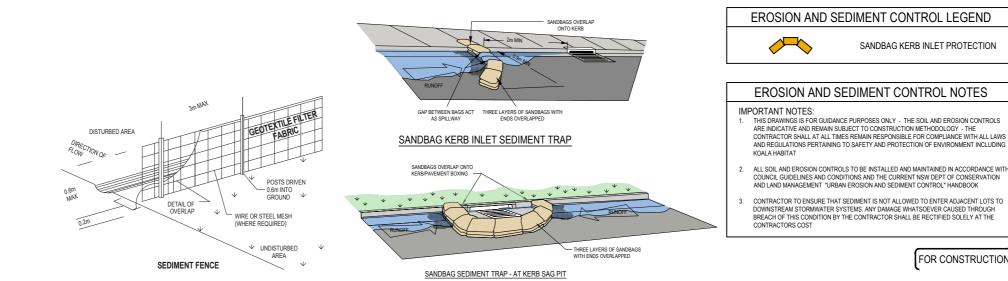

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		В	05/08/19	DESIGN AMENDMENT	AM	Action Plans. Do not scale measure from drawings. Figured dimensions			NESBITT	DAU
	m: 0426 957 518	с	17/02/20	DA DOCUMENTATION	LRP	are to be used only. The Builder/Contractor shall check and verify all levels and	DEMOLIS	HED	PROJECT ADDRESS	DATE
┦┶╌╞╸	e:operations@actionplans.com.au w: www.actionplans.com.au	D	13/12/21	DA AMENDMENT	AM	dimensions on site prior to commencement of any work, creation of shop drawings, or fabrication of components.	CONCRE		56 SPENCER ROAD,	Monday,
	, , , , , , , , , , , , , , , , , , ,					All errors and omissions are to be verified by the Builder/Contractor and referred to the designer prior to the commencement of works.	LANDSC	APE	MOSMAN SYDNEY NSW AUSTRALIA	2021

FOR CONSTRUCTION

EROSION AND SEDIMENT CONTROL NOTES

SITE INSPECTION AND MAINTENANCE INSTRUCTIONS

- THE SITE SUPERINTENDENT WILL INSPECT THE SITE AT LEAST WEEKLY AND AT THE CONCLUSION OF EVERY STORM EVENT TO:
- ENSURE THAT DRAINS OPERATE PROPERLY AND TO EFFECT ANY NECESSARY
- ENSING THAT DRAINS OF EARLY FROM A TRADUCTION OF THE AND THE ADDRAINS OF EARLY AND THE ADDRAINS OF EARLY AND THE ADDRAINS OF EARLY AND THE ADDRAINS OF THE ADD VELOCITY FLOWS ESPECIALLY WATERWAYS AND PAVED AREAS.
- REMOVE TRAPPED SEDIMENT WHENEVER THE DESIGN CAPACITY OF THAT STRUCTURE HAS BEEN EXCEEDED
- STRUCTURE HAS BEEN EXACEDUE ENSURE REHABILITATED LANDS HAVE EFFECTIVELY REDUCED THE EROSION HAZARD AND TO INITIATE UPGRADING OR REPAIR AS NECESSARY. CONSTRUCT ADDITIONAL EROSION AND/OR SEDIMENT CONTROL WORKS AS MIGHT BECOME NECESSARY TO ENSURE THE DESIRED PROTECTION IS GIVEN TO
- DOWNSLOPE LANDS AND WATERWAYS, MAKE ONGOING CHANGES TO THE PLAN WHERE IT PROVES INADEQUATE IN PRACTICE OR IS SUBJECTED TO CHANGES IN CONDITIONS ON THE WORK-SITE OR ELSEWHERE IN THE CATCHMENT
- CONDITIONS ON THE WORK-SITE OF ELSEWHERE IN THE CATOMIENT. MAINTAIN EROSION AND SEDIMENT CONTROL STRUCTURES IN A FULLY FUNCTIONING CONDITION UNTIL ALL EARTHWORK ACTIVITIES ARE COMPLETED AND THE SITE IS REHABILITATED.
- THE SITE SUPERINTENDENT WILL KEEP A LOGBOOK MAKING ENTRIES AT LEAST WEEKLY. IMMEDIATELY BEFORE FORECAST RAIN AND AFTER RAINFALL, ENTRIES WILL INCLUDE:
- THE VOLUME AND INTENSITY OF ANY RAINFALL EVENTS.
- THE VOLUME AND INTENSITION ANT RAINFALL EVENTS. THE CONDITION OF ANY SOLL AND WATER MANAGEMENT WORKS. THE CONDITION OF VEGETATION AND ANY NEED TO IRRIGATE. THE NEED FOR DUST PREVENTION STRATEGIES.
- ANY REMEDIAL WORKS TO BE UNDERTAKEN. THE LOGBOOK WILL BE KEPT ON-SITE AND MADE AVAILABLE TO ANY AUTHORISED PERSON UPON REQUEST. IT WILL BE GIVEN TO THE PROJECT MANAGER AT THE CONCLUSION OF THE WORKS.

WASTE CONTROL INSTRUCTIONS

- ACCEPTABLE BINS WILL BE PROVIDED FOR ANY CONCRETE AND MORTAR SI URRIES. PAINTS ACID WASHING, LIGHTWEIGHT WASTE MATERIALS AND LITTER, CLEARANCE SERVICES WILL BE PROVIDED AT LEAST WEEKLY. DISPOSAL OF WASTE WILL BE IN A MANNER APPROVED BT
- ALL POSSIBLE POLLUTANT MATERIALS ARE TO BE STORED WELL CLEAR OF ANY POORLY DRAINED AREAS, FLOOD PRONE AREAS, STREAMBANKS, CHANNELS AND STORMWATER DRAINAGE AREAS. STORE SUCH MATERIALS IN A DESIGNATED AREA UNDER COVER WHERE POSSIBLE AND WITHIN CONTAINMENT BUNDS.
- ALL SITE STAFF AND SUB-CONTACTORS ARE TO BE INFORMED OF THEIR OBLIGATION TO USE WASTE CONTROL FACILITIES PROVIDED.
- 4. ANY DE-WATERING ACTIVITIES ARE TO BE CLOSELY MONITORED TO ENSURE THAT WATER IS NOT POLLUTED BY SEDIMENT, TOXIC MATERIALS OR PETROLEUM PRODUCTS
- PROVIDE DESIGNATED VEHICULAR WASHDOWN AND MAINTENANCE AREAS WHICH ARE TO HAVE CONTAINMENT BUNDS.

EROSION AND SEDIMENT CONTROL NOTES

GENERAL INSTRUCTIONS

- THIS SOIL AND WATER MANAGEMENT PLAN IS TO BE READ IN CONJUNCTION WITH OTHER ENGINEERING PLANS RELATING TO THIS DEVELOPMENT
- CONTRACTORS WILL ENSURE THAT ALL SOIL AND WATER MANAGEMENT WORKS ARE UNDERTAKEN AS INSTRUCTED IN THIS SPECIFICATION AND CONSTRUCTED FOLLOWING THE GUIDELINES OF "MANAGING URBAN STORMWATER SOILS AND CONSTRUCTION", DEPT OF HOUSING, 1998 (BLUE BOOK).
- ALL SUBCONTRACTORS WILL BE INFORMED OF THEIR RESPONSIBILITIES. IN REDUCING THE POTENTIAL FOR SOIL EROSION AND POLLUTION TO DOWNSLOPE AREAS

LAND DISTURBANCE INSTRUCTIONS


- DISTURBANCE TO BE NO FURTHER THAN 5 (PREFERABLY 2) METRES FROM THE EDGE OF ANY ESSENTIAL ENGINEERING ACTIVITY AS SHOWN ON APPROVED PLANS, ALL SITE WORKERS WILL CLEARLY RECOGNISE THESE ZONES THAT, WHERE APPROPRIATE, ARE IDENTIFIED WITH BARRIER FENCING (UPSLOPE) AND SEDIMENT FENCING (DOWNSLOPE) OR SIMILAR
- ACCESS AREAS ARE TO BE LIMITED TO A MAXIMUM WIDTH OF 10 METRES THE SITE MANAGER WILL DETERMINE AND MARK THE LOCATION OF THESE ZONES ON-SITE. ALL SITE WORKERS WILL CLEARLY RECOGNISE THESE BOUNDARIES THAT, WHERE APPROPRIATE, ARE IDENTIFIED WITH BARRIER FENCING (UPSLOPE) AND SEDIMENT FENCING (DOWNSLOPE) OR SIMILAR MATERIALS
- ENTRY TO LANDS NOT REQUIRED FOR CONSTRUCTION OR ACCESS IS PROHIBITED EXCEPT FOR ESSENTIAL THINNING OF PLANT GROWT
- WORKS ARE TO PROCEED IN THE FOLLOWING SEQUENCE:
- INSTALL ALL BARRIER AND SEDIMENT FENCING WHERE SHOWN ON THE PLAN.
- INSTALL ALL BARNIER AIN SEDIMENT FENCING WHERE SHOWN ON THE CONSTRUCT THE STABLISED SITE ACCESS. CONSTRUCT DIVERSION DRAINS AS REQUIRED. INSTALL MESH AND GRAVEL INLETS FOR ANY ADJACENT KERB INLETS.
- INSTALL GEOTEXTILE INLET FILTERS AROUND ANY ON-SITE DROP INLET PITS.
- CLEAR SITE AND STRIP AND STOCKPILE TOPSOIL IN LOCATIONS SHOWN ON THE PLAN. LINDERTAKE ALL ESSENTIAL CONSTRUCTION WORKS ENSURING THAT ROOF AND/OR
- PAVED AREA STORMWATER SYSTEMS ARE CONNECTED TO PERMANENT DRAINAGE AS
- PAVED AREA STORMWATER STSTEINS ARE CONNECTED TO PERMANENT DRAIT SOON AS PRACTICABLE. GRADE LOT AREAS TO FINAL GRADES AND APPLY PERMANENT STABILISATION (LANDSCAPING) WITHIN 20 DAYS OF COMPLETION OF CONSTRUCTION WORKS. REMOVE TEMPORARY EROSION CONTROL MEASURES AFTER THE PERMANENT LANDSCAPING HAS BEEN COMPLETED.
- 5ENSURE THAT SLOPE LENGTHS DO NOT EXCEED 80 METRES WHERE PRACTICABLE. SLOPE SENSING THAT SLOPE LENGTHS UD NOT EXCEED OWNETRES WHERE FRACTICABLE. SLOPE LENGTHS ARE DETERMINED BY SILTATION FRACTING AND ACTCH DRAIN SPACING 6. ON COMPLETION OF MAJOR WORKS LEAVE DISTURBED LANDS WITH A SCARIFIED SURFACE TO ENCOURAGE WATER INFILTRATION AND ASSIST WITH KEYING TOPSOIL LATER.

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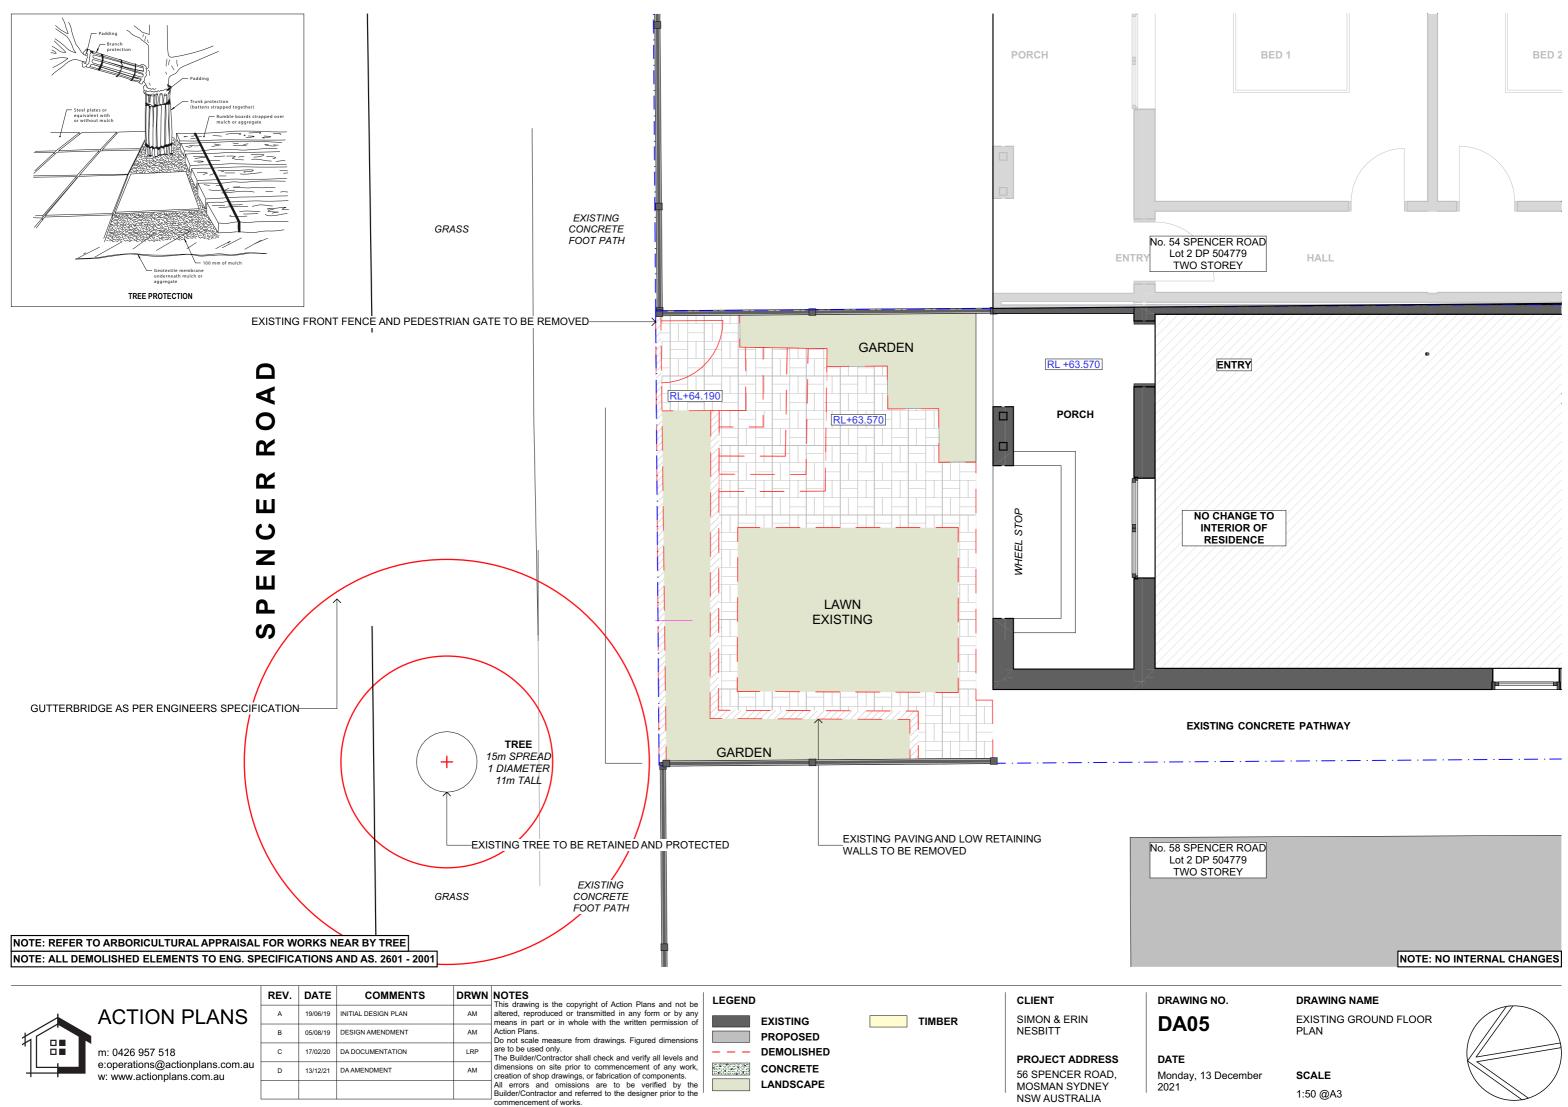
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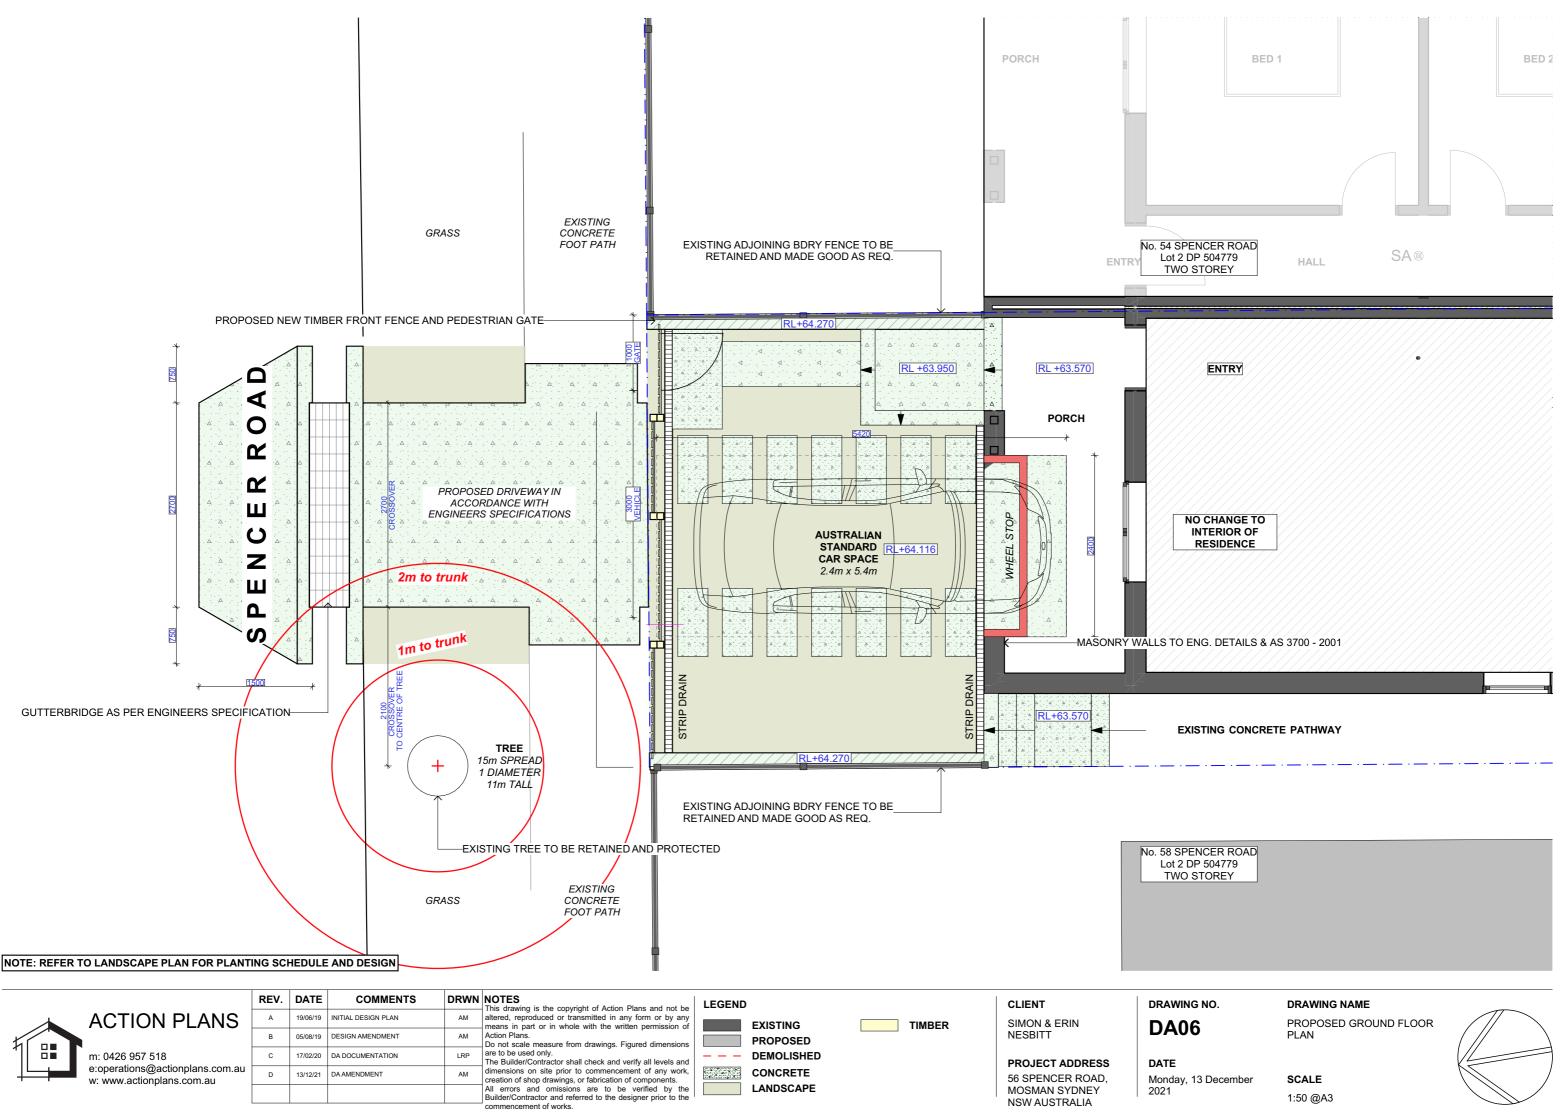
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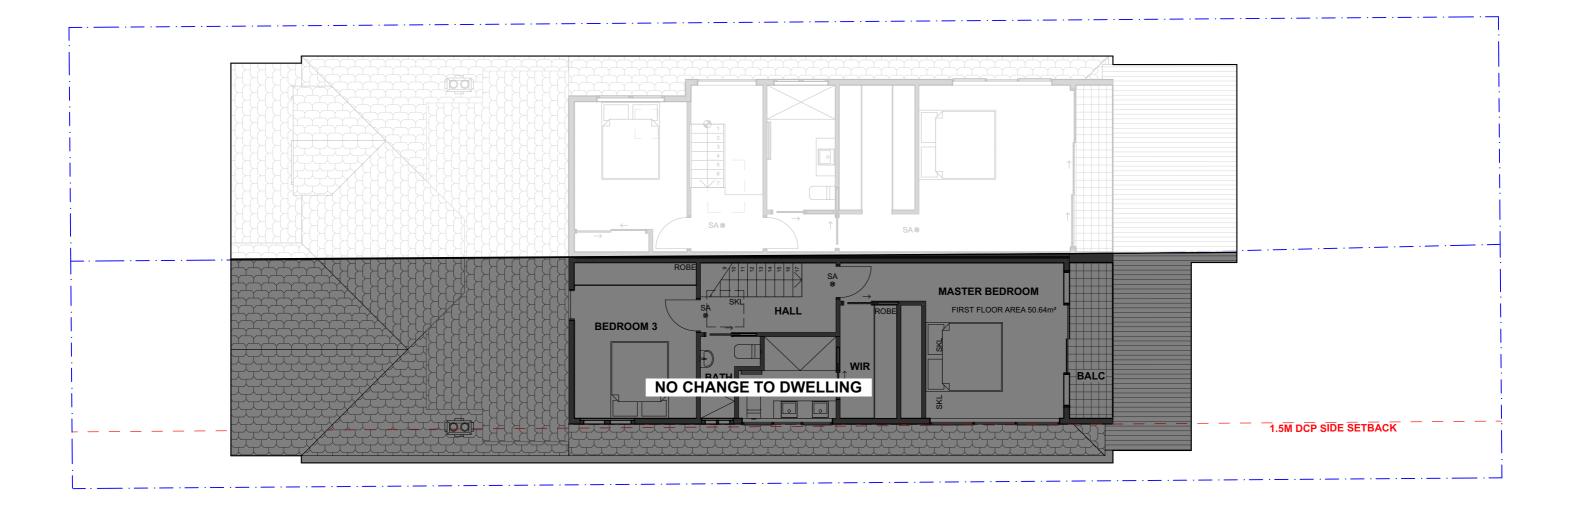
SEDIMENT / EROSION CONTROL PLAN



SCALE 1:200 @A3



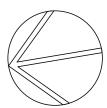




NOTE: ALL DEMOLISHED ELEMENTS TO ENG. SPECIFICATIONS AND AS. 2601 - 2001

NOTE: NO INTERNAL CHANGES

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15	e:operations@actionplans.com.au w: www.actionplans.com.au	D	13/12/21	DA AMENDMENT	AM		CONCRETE		PROJECT ADDRESS 56 SPENCER ROAD,	Monday, 13 De
						All errors and omissions are to be verified by the Builder/Contractor and referred to the designer prior to the commencement of works.		LANDSCAPE	MOSMAN SYDNEY NSW AUSTRALIA	2021


ING NO.

DRAWING NAME EXISTING FIRST FLOOR PLAN

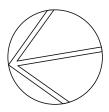

13 December

SCALE 1:100 @A3

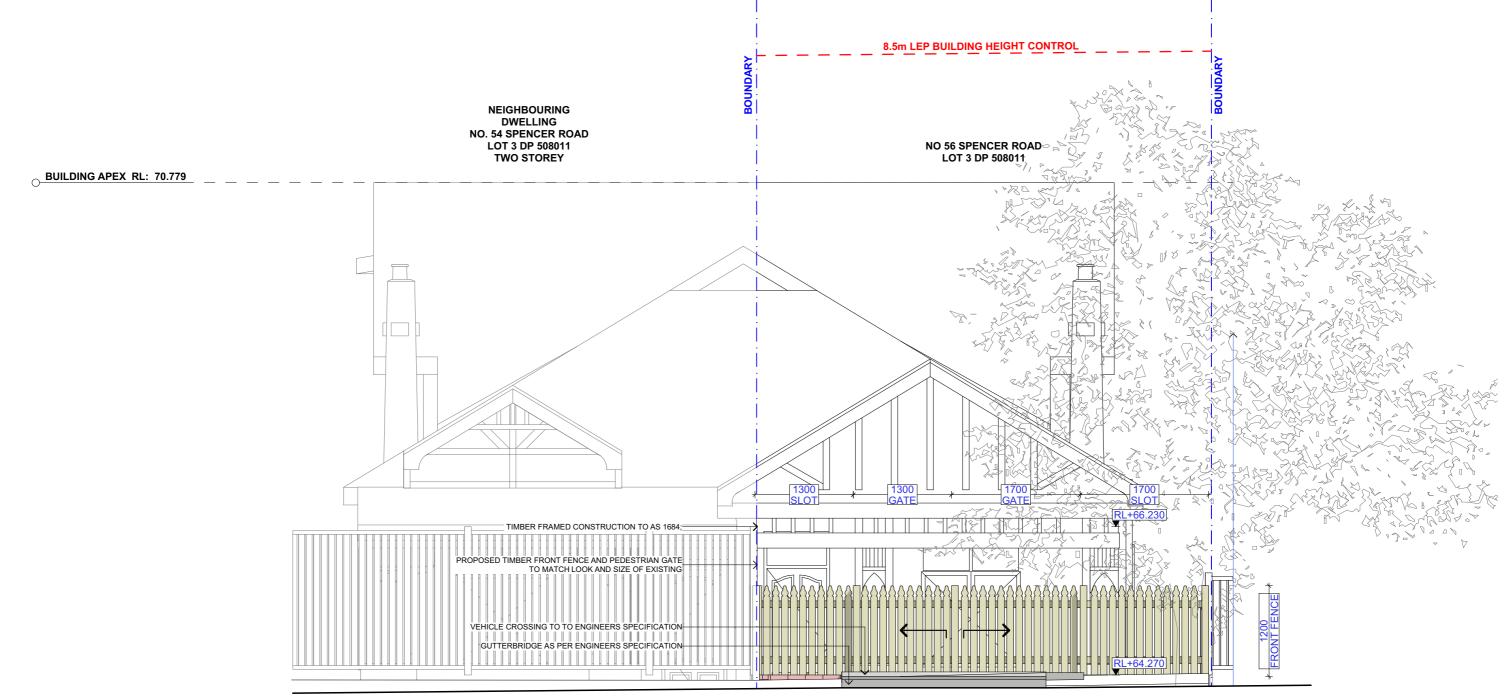

NATURAL GROUND LINE



			REV.	DATE	COMMENTS	DRWN	NOTES This drawing is the copyright of Action Plans and not be	LEGEND)		CLIENT	DRAWING NO
		ACTION PLANS	A	19/06/19	INITIAL DESIGN PLAN	АМ	altered, reproduced or transmitted in any form or by any means in part or in whole with the written permission of		TIMBER	METAL ROOFING	SIMON & ERIN	DA08
5			в	05/08/19	DESIGN AMENDMENT	AM	Action Plans. Do not scale measure from drawings. Figured dimensions		WEATHERBOARD	TILED ROOFING	NESBITT	DAUO
1		m: 0426 957 518	С	17/02/20	DA DOCUMENTATION	LRP	are to be used only. The Builder/Contractor shall check and verify all levels and			RENDER	PROJECT ADDRESS	DATE
15	┤└──╪━━┛┛	e:operations@actionplans.com.au w: www.actionplans.com.au	D	13/12/21	DA AMENDMENT	AM	dimensions on site prior to commencement of any work, creation of shop drawings, or fabrication of components.			EXISTING	56 SPENCER ROAD,	Monday, 13 De
							All errors and omissions are to be verified by the Builder/Contractor and referred to the designer prior to the commencement of works.		CONCRETE		MOSMAN SYDNEY NSW AUSTRALIA	2021


GROUND FLOOR LEVEL RL: 63.570


VING NO.

DRAWING NAME NORTH ELEVATION

ay, 13 December

SCALE 1:50 @A3

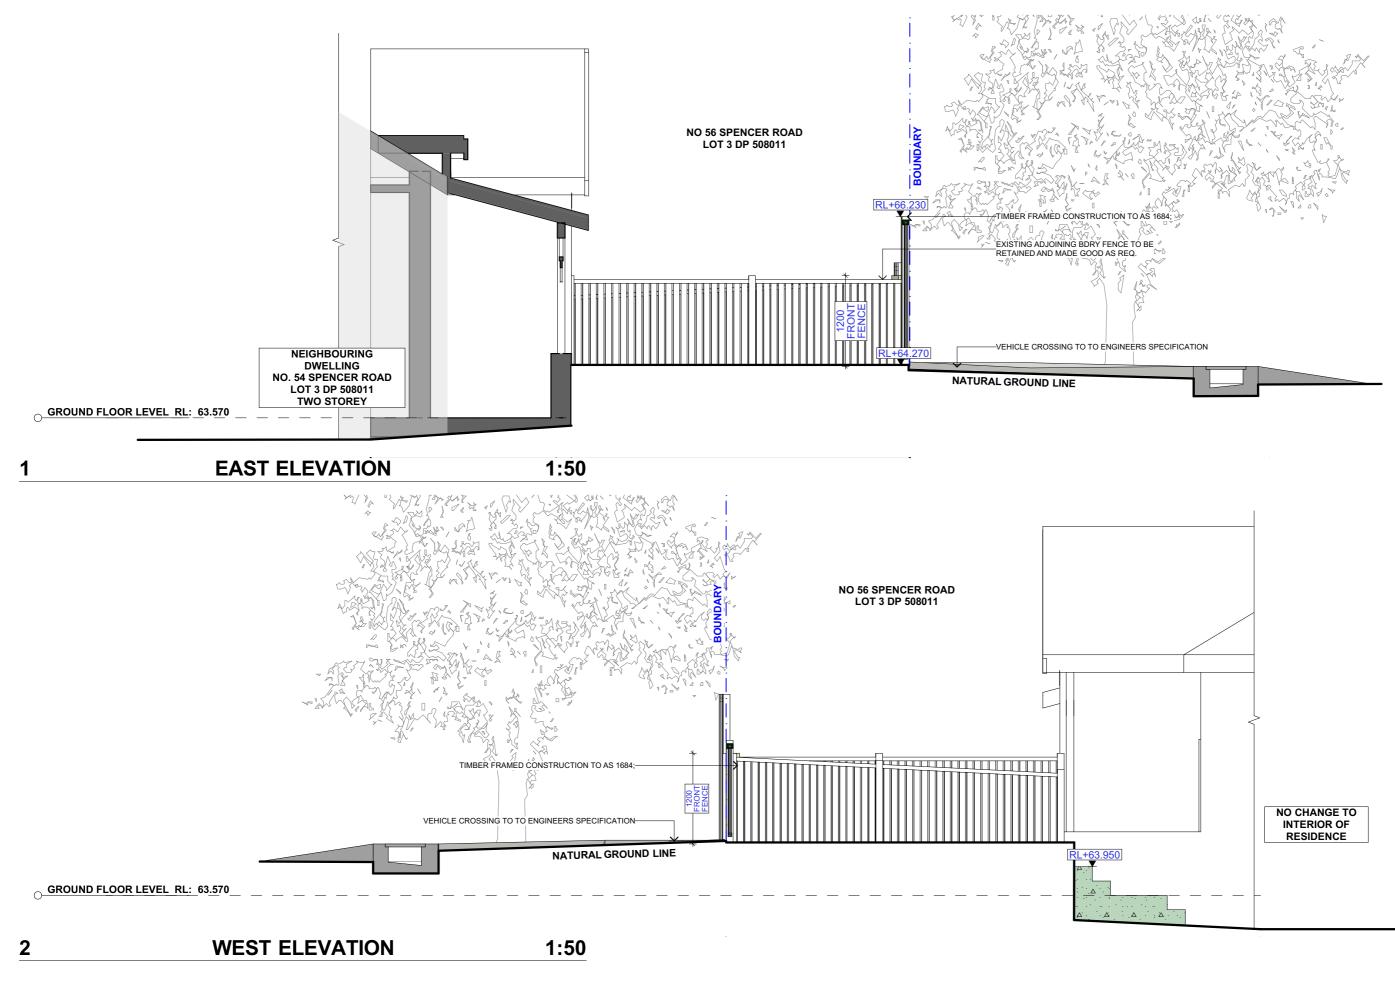

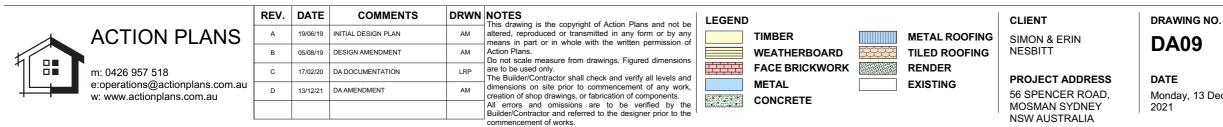



DRAWING NAME

EAST / WEST ELEVATION

Monday, 13 December

SCALE 1:50 @A3

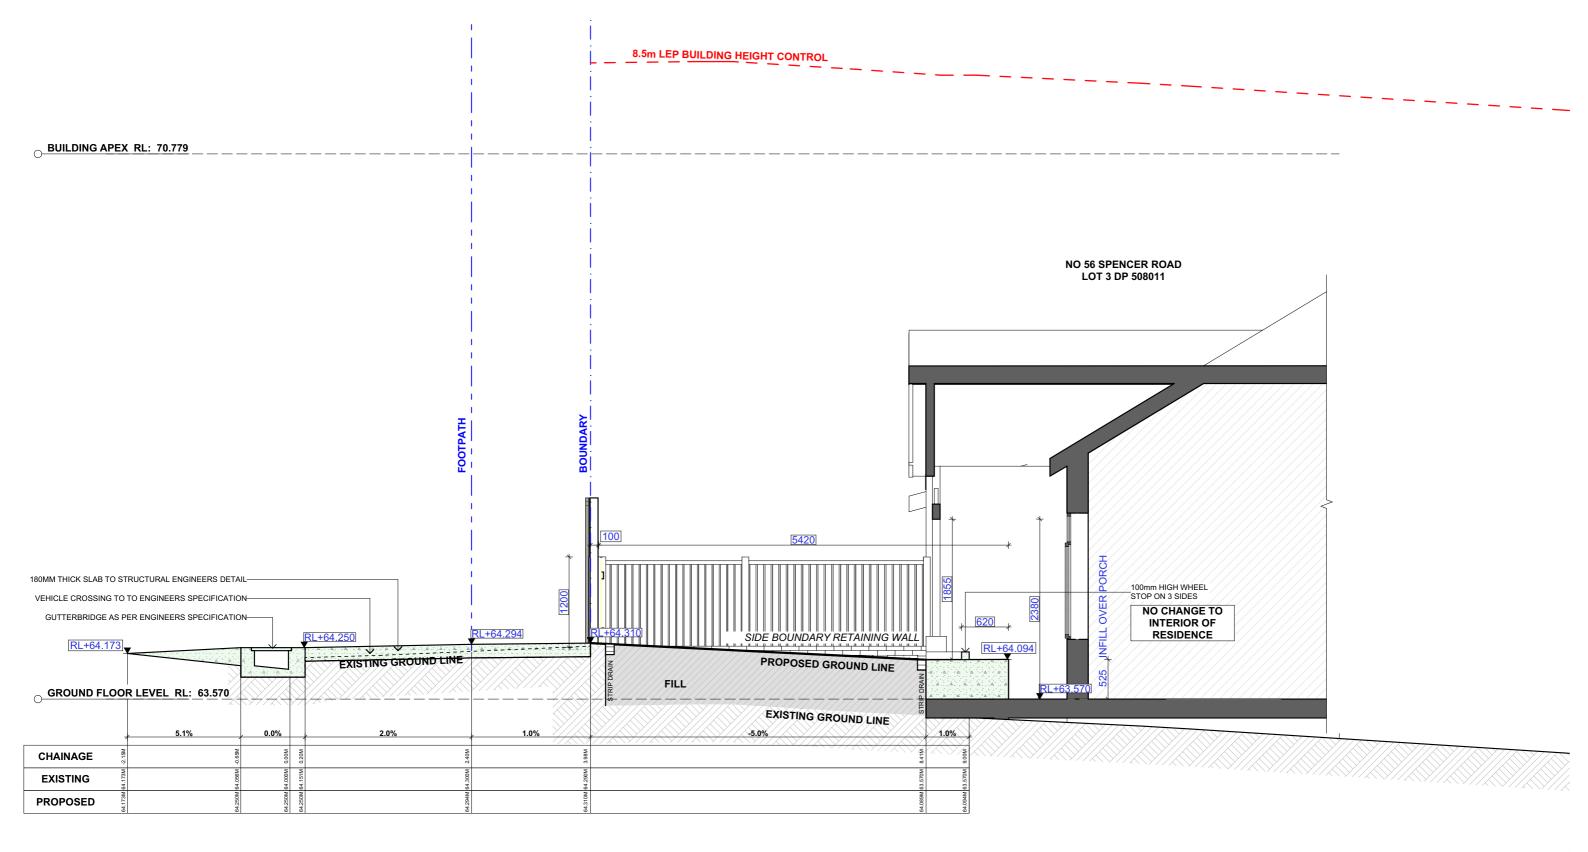

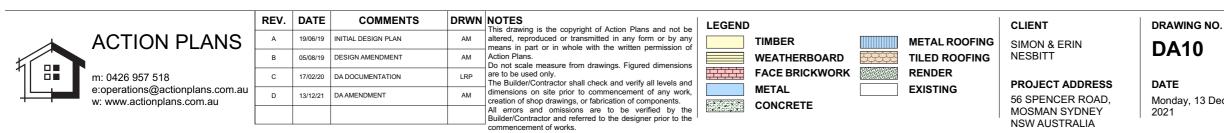

DRAWING NAME DRIVEWAY LONG SECTION


Monday, 13 December

SCALE 1:50 @A3

EXISTING AREA CALCULATIONS 1:100

1

2

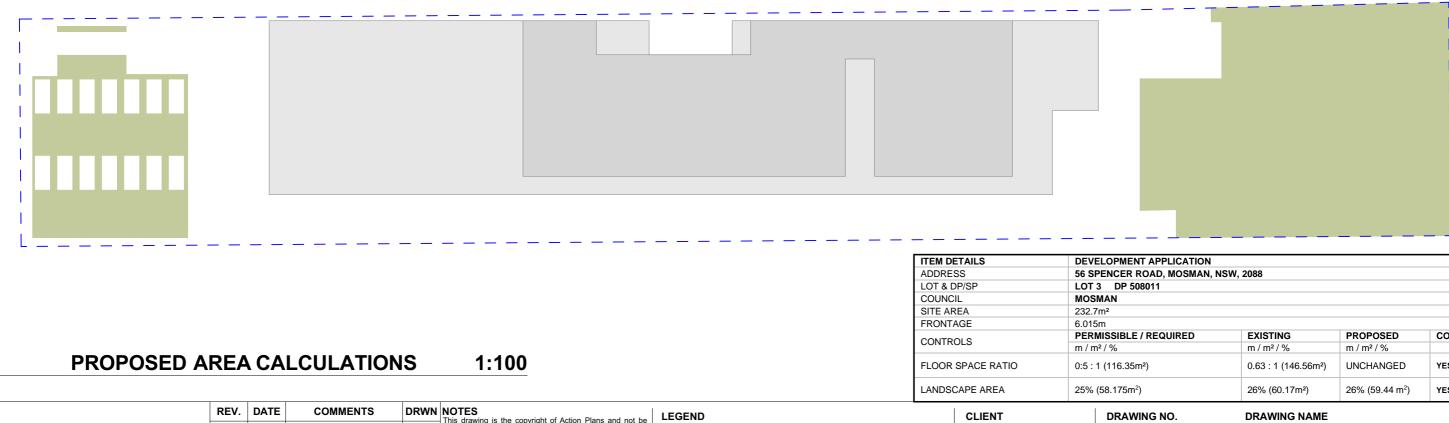

	REV.	DATE	COMMENTS		NOTES This drawing is the copyright of Action Plans and not be	LEGEND	
ACTION PLANS	А	19/06/19	INITIAL DESIGN PLAN	AM	altered, reproduced or transmitted in any form or by any means in part or in whole with the written permission of		LANDSCAPE AREA
	в	05/08/19	DESIGN AMENDMENT	AM	Action Plans. Do not scale measure from drawings. Figured dimensions		BUILDING ENVELOPE
□■ m: 0426 957 518	С	17/02/20	DA DOCUMENTATION	LRP	are to be used only. The Builder/Contractor shall check and verify all levels and		
e:operations@actionplans.com.au	D	13/12/21	DA AMENDMENT	AM	timensions on site prior to commencement of any work, creation of shop drawings, or fabrication of components.		
					All errors and omissions are to be verified by the Builder/Contractor and referred to the designer prior to the commencement of works.		

IT APPLICATION											
ROAD, MOSMAN, NSW, 2088											
08011											
/ REQUIRED	EXISTING	PROPOSED	COMPLIANCE								
	m / m² / %	m / m² / %									
m²)	0.63 : 1 (146.56m ²)	UNCHANGED	YES								
²)	26% (60.17m ²)	26% (59.44 m ²)	YES								

DA11

DATE

SIMON & ERIN NESBITT


PROJECT ADDRESS

56 SPENCER ROAD,


MOSMAN SYDNEY NSW AUSTRALIA


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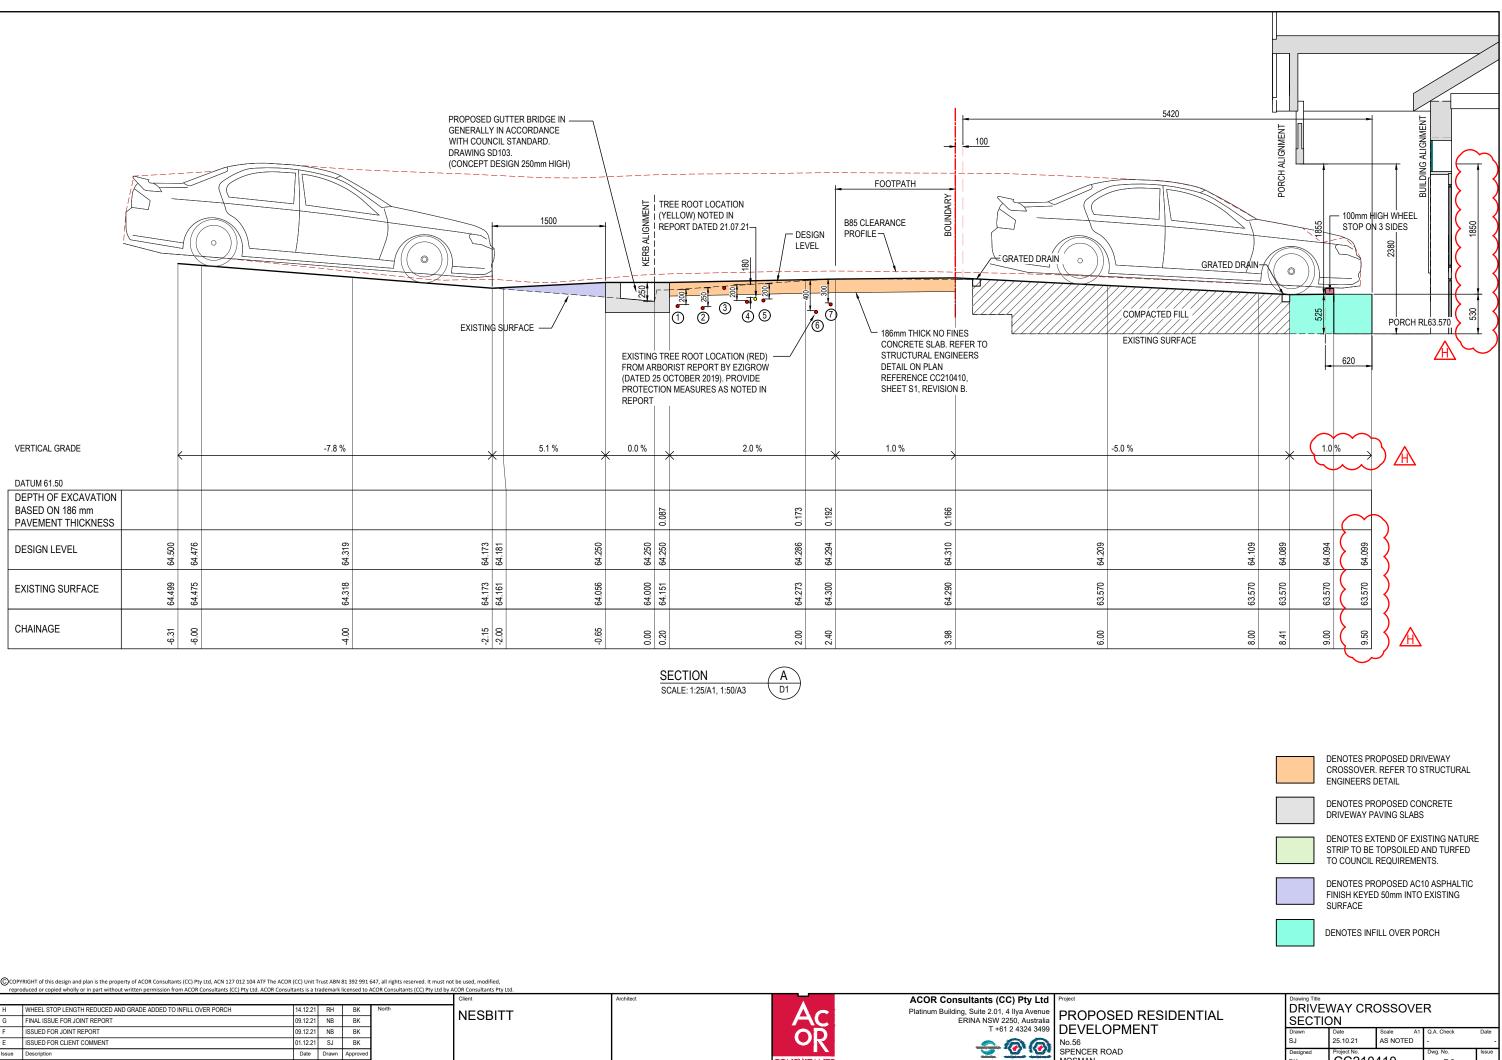
AREA CALCULATIONS

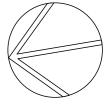

SCALE 1:100 @A3



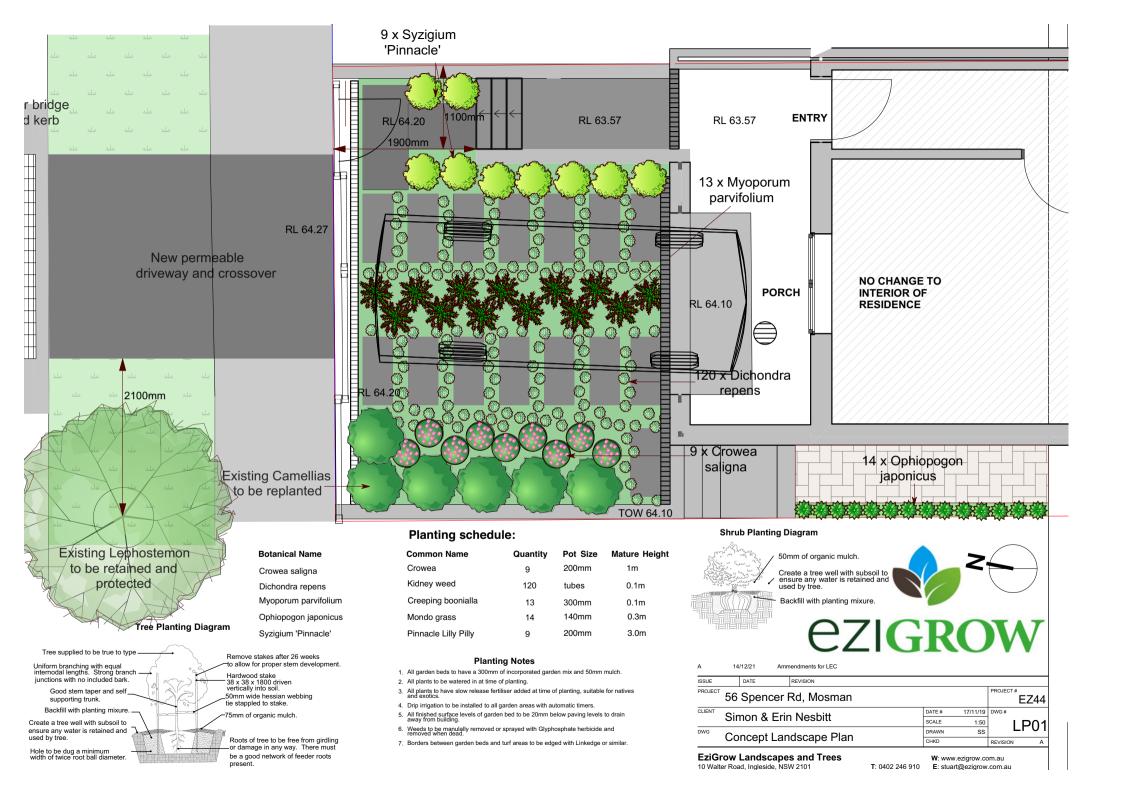

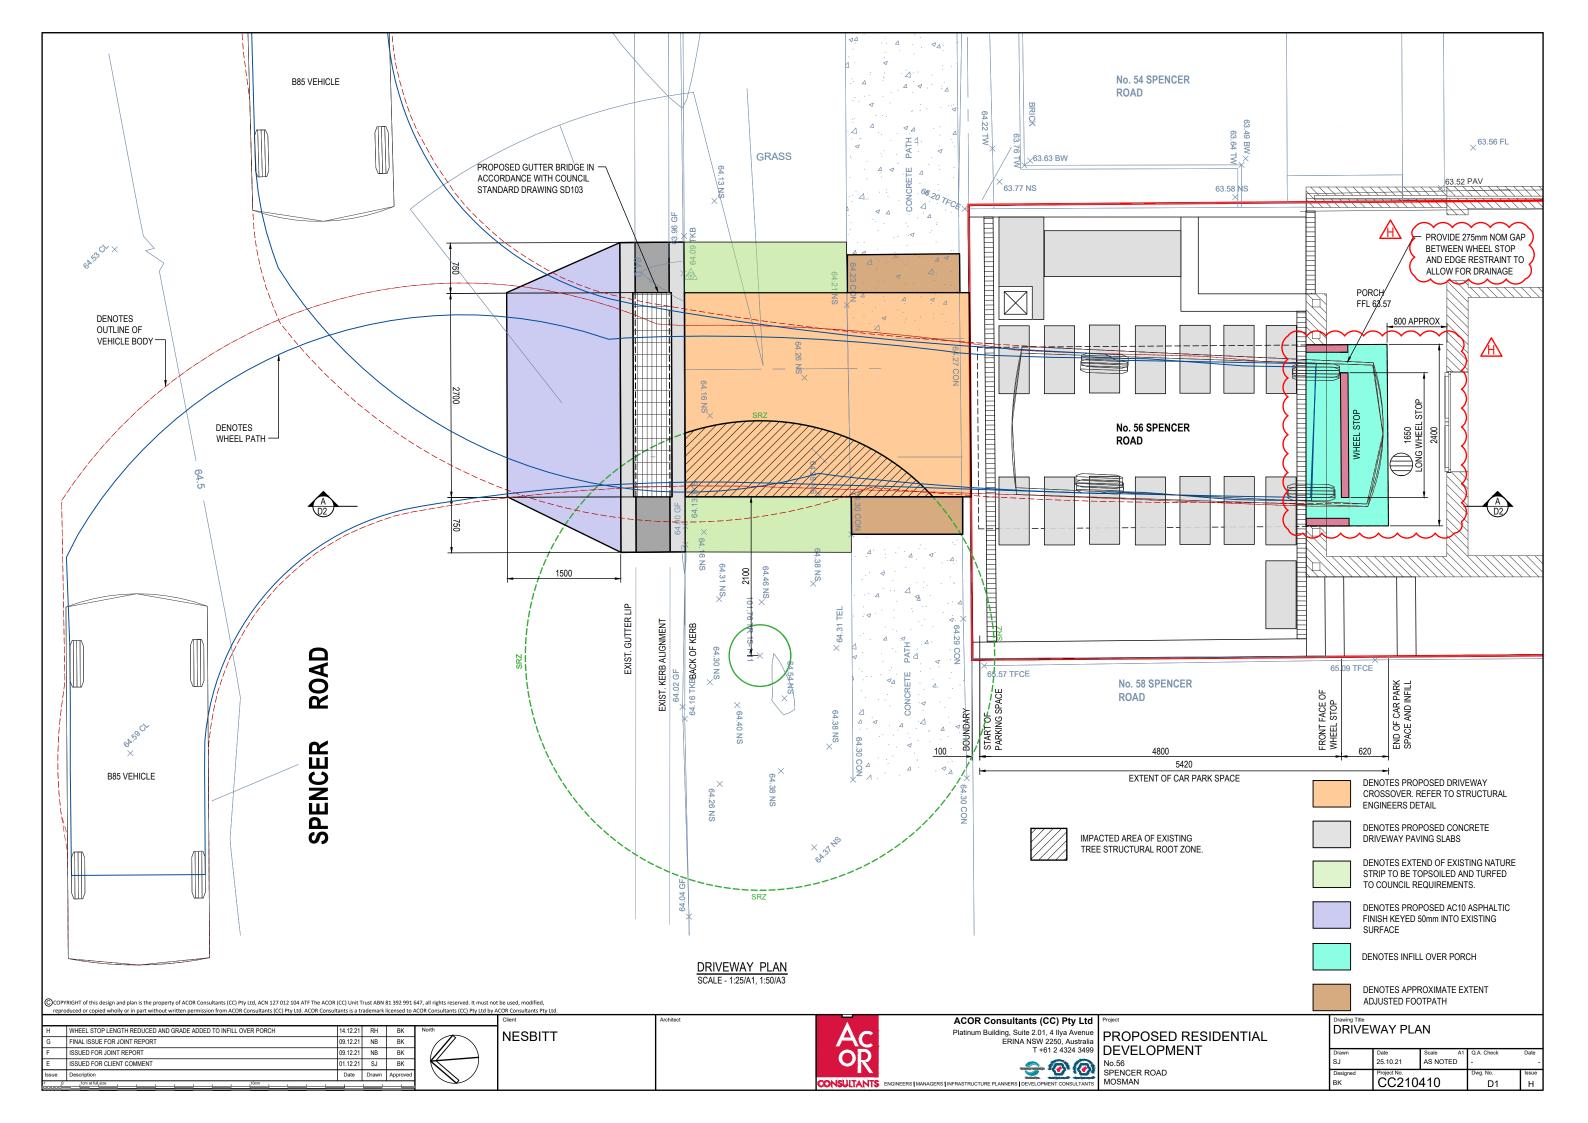



Date Drawn Appro


BIDENTIAL		R			
	Drawn	Date	Scale A1	Q.A. Check	Date
	SJ	25.10.21	AS NOTED	-	-
	Designed	Project No.		Dwg. No.	Issue
	вк	CC210410		D2	Н

SPENCER ROAD

MOSMAN

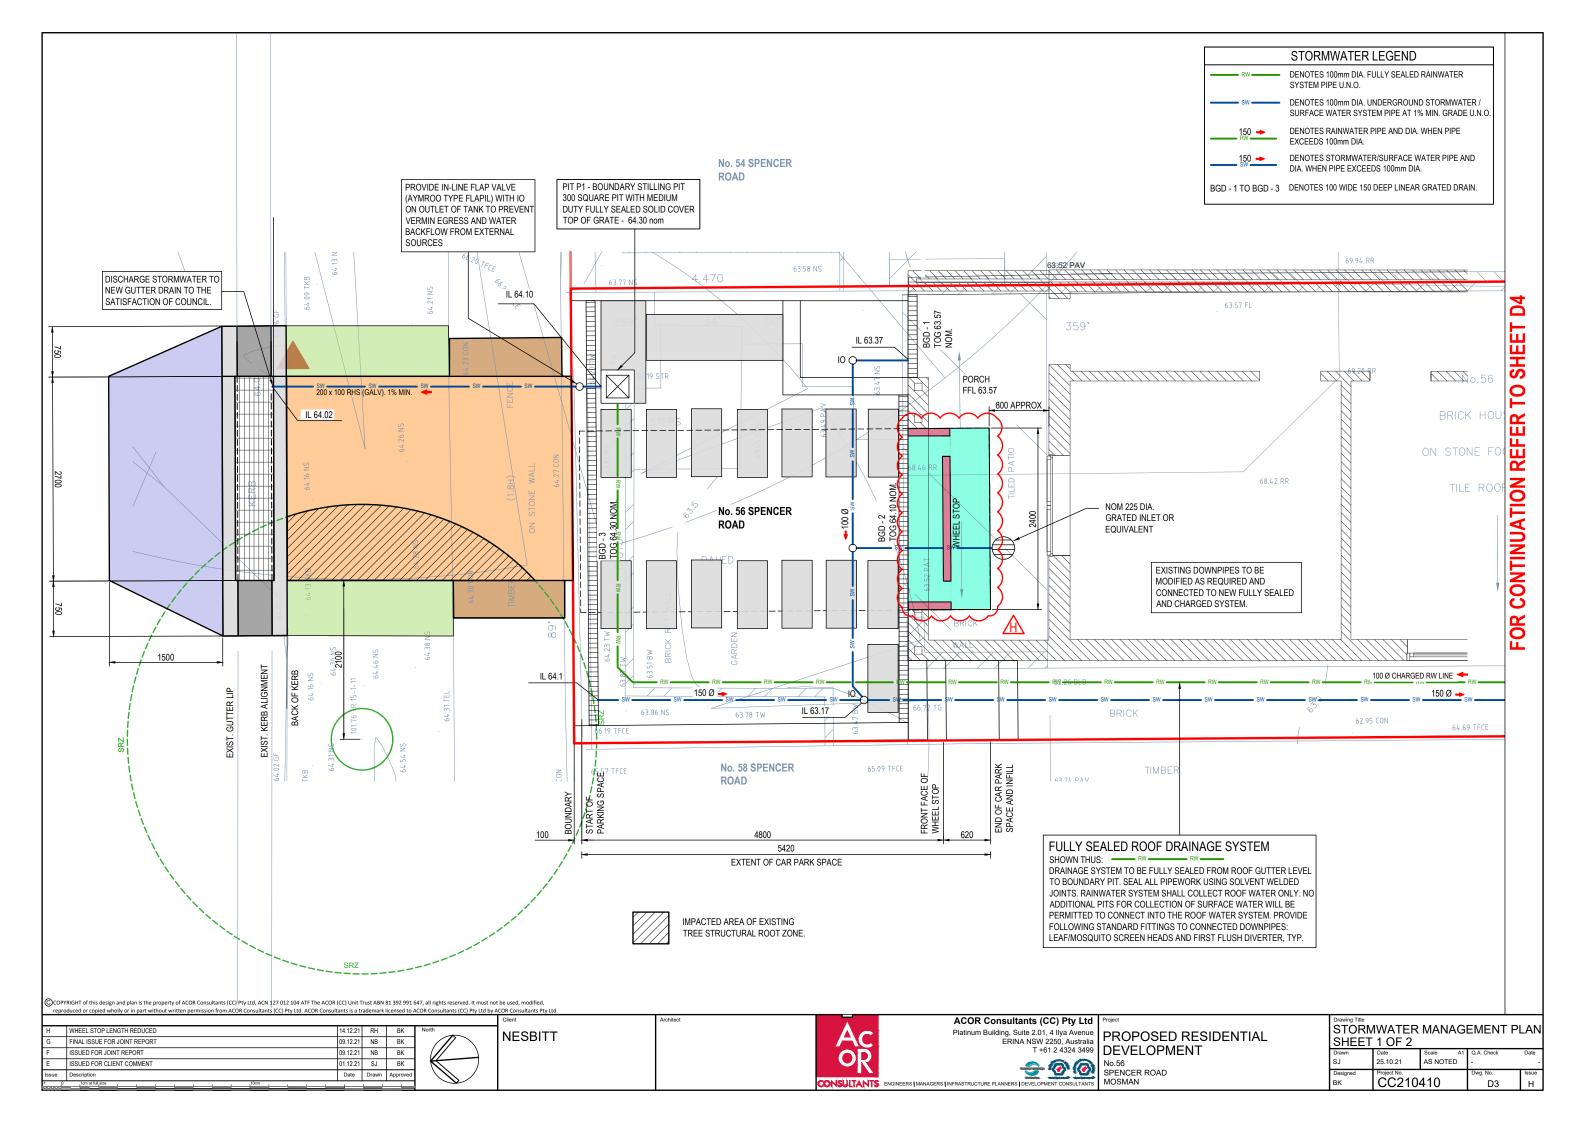

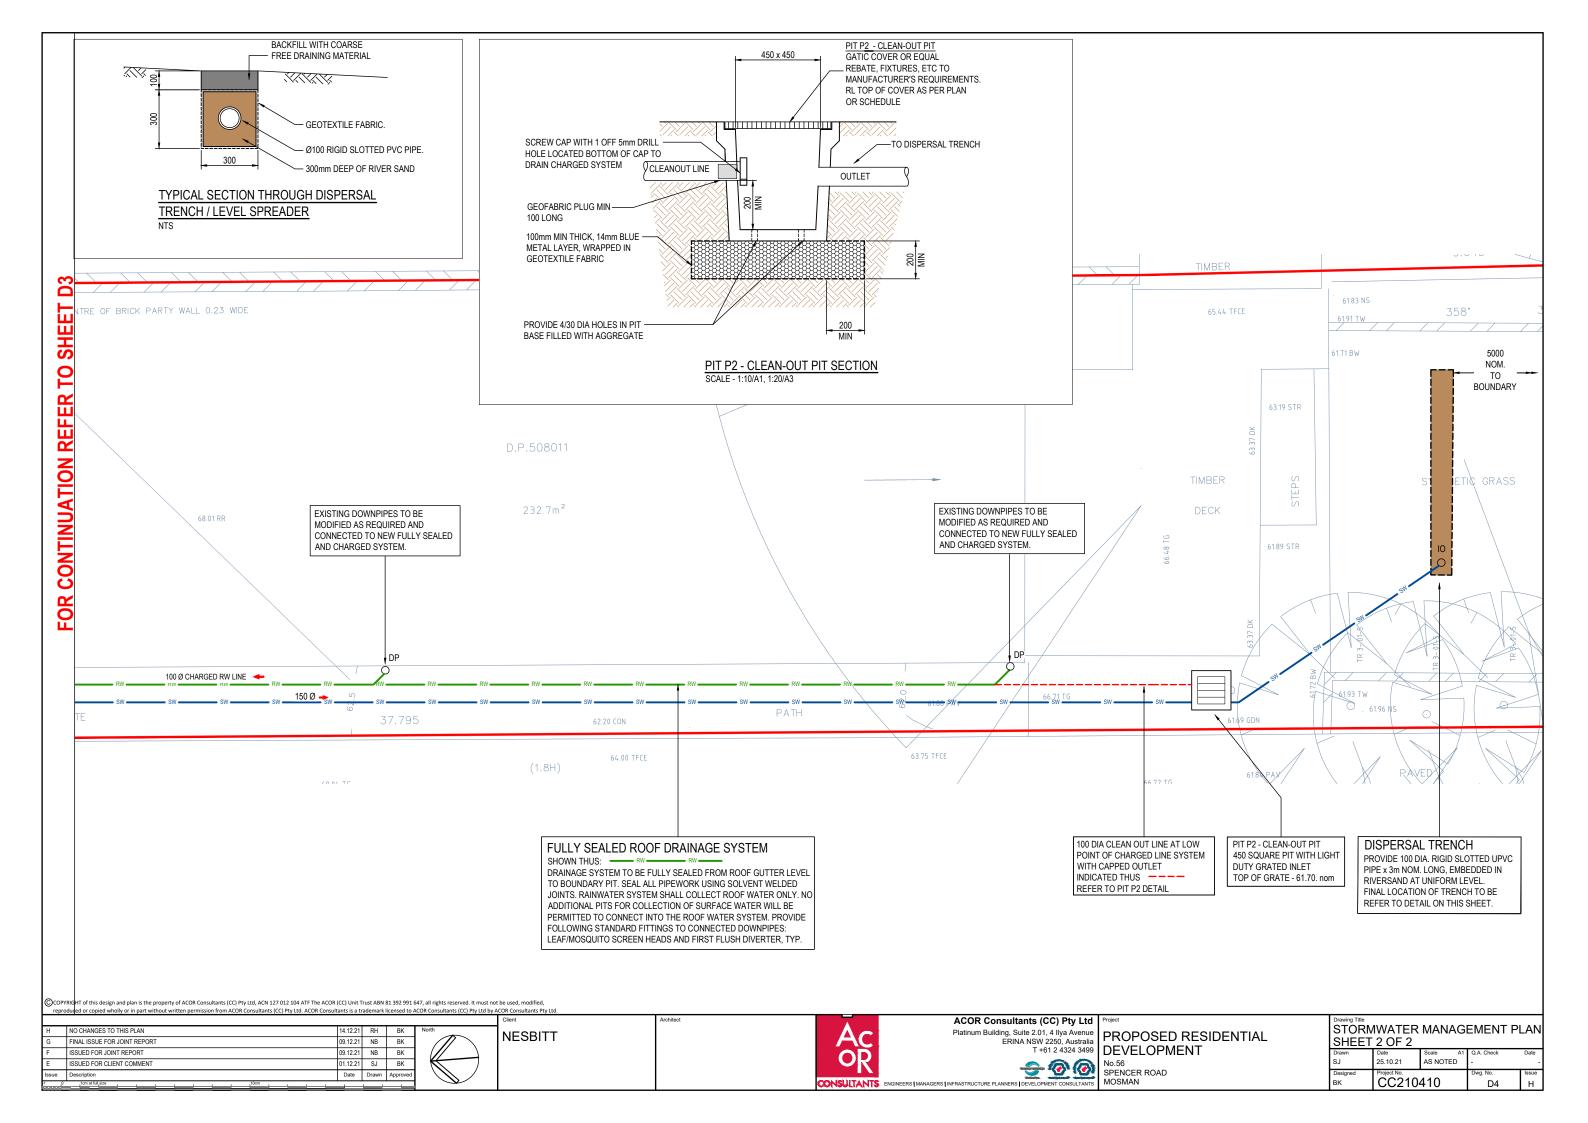

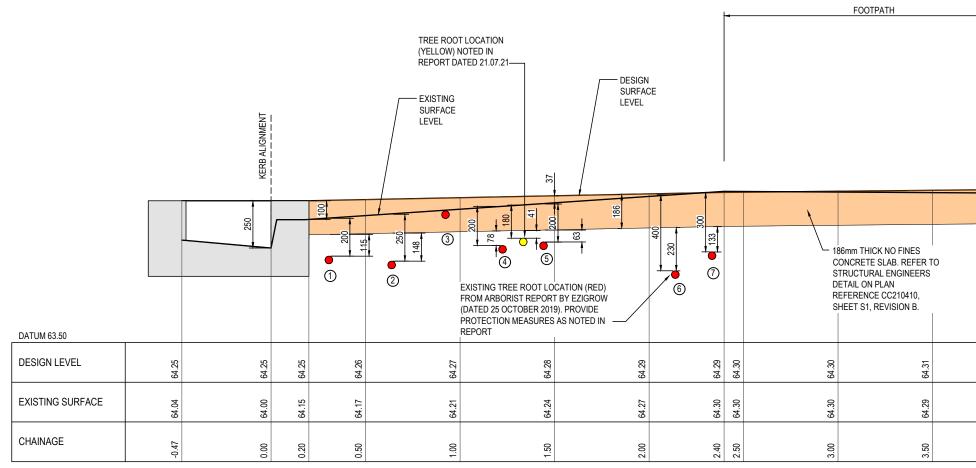

LONG SECTION PROPOSED AND EXISTING LEVELS IN FOOTPATH RESERVE


SCALE - 1:10/A1, 1:20/A3

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						Client	Architect	A	ACOR Consultants
					North	NESBITT			Platinum Building, Suite 2.0
					1 / / > 1				ERINA NSV
									Т
Α	ISSUE FOR INFORMATION	13.12.21	I NB	BK					
Issue	Description	Date	Drawn	Approved					<u> </u>
1 0	10m at full size 10cm		ļ					CONSULTANTS	ENGINEERS MANAGERS INFRASTRUCTURE PLANNERS DEVELO

ACOR Consultants (CC) Pty Ltd Platinum Building, Suite 2.01, 4 lya Avenue ERINA NSW 2250, Australia T +61 2 4324 3499 DEVELOPMENT 2 @ @ No.56 SPENCER ROAD MOSMAN

ULTANTS

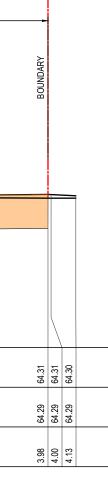

	PROPOSED AND EXISTING LEVELS							
1	Drawn	Date	Scale A1	Q.A. Check	Date			
	NB	13.12.21	AS NOTED	-	-			
	Designed	Project No.		Dwg. No.	Issue			
	BK	CC210	410	D5	А			

